
MARTY'S FIRST STOP

421 US-2, Danville Vermont 05828 May 14, 2024

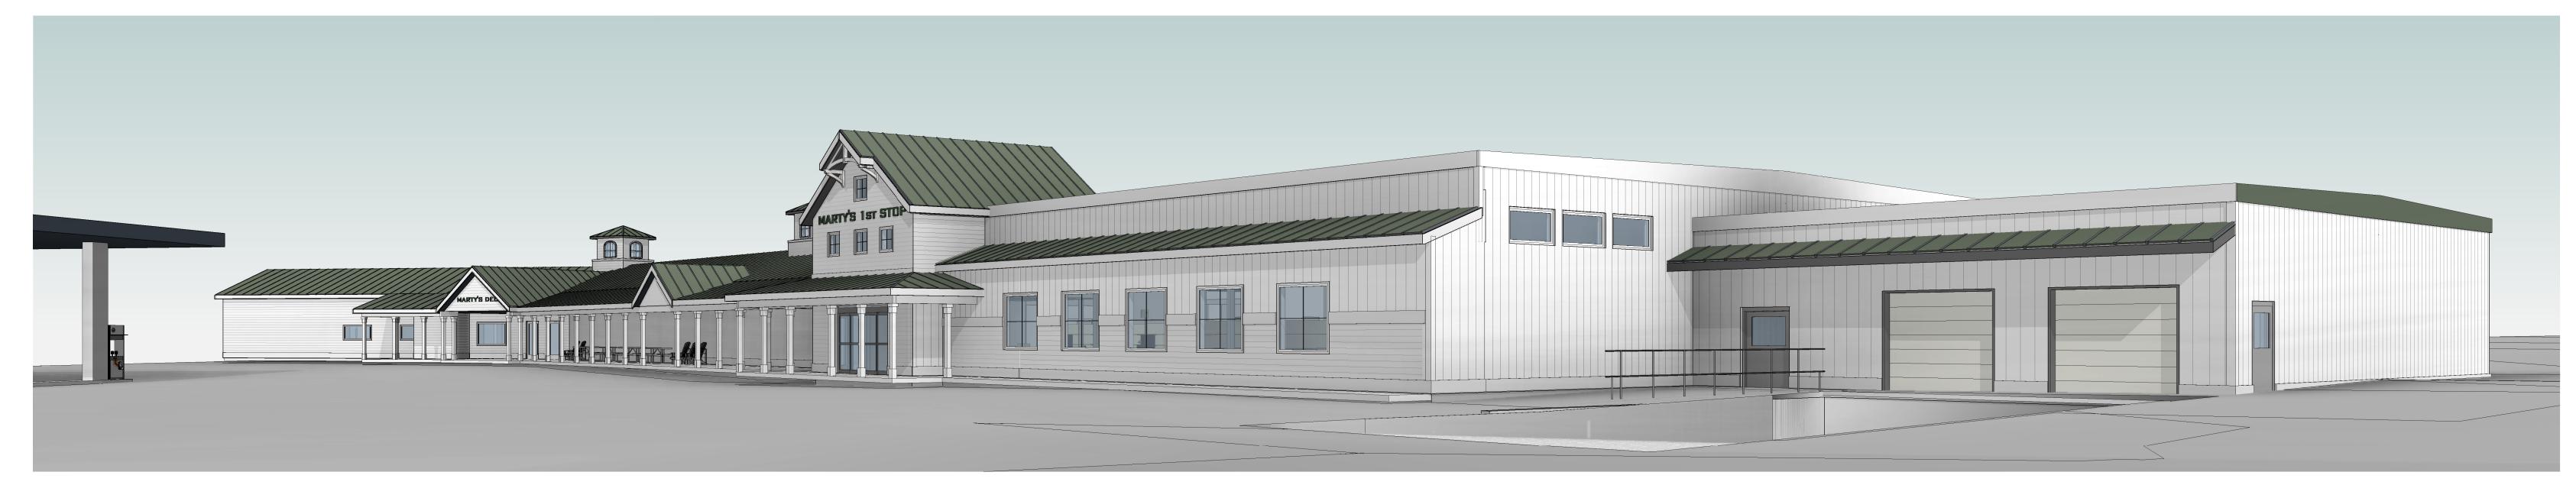

CIVIL ENGINEERS

Mumley Engineering, INC.

46 Hutchins Street
Morrisville, Vermont 05661
Tel: (802) 881-6314
www.mumleyengineering.com

ARCHITECTS

EHDanson Associates, PLLC

357 Mestern Avenue, Suit 104 St. Johnsbury, Vermont 05819-2795 Tel: 802-748-5239 www.ehdanson.com

STRUCTURAL ENGINEER

DeWolfe Engineering Associates

317 River Street P.O. Box 1576 Montpelier, Vermont 05601-1576 Tel: 802-223-4727 www.dirtsteel.com

MECHANICAL ENGINEERS

Engineering Services of Vermont

Mechanical & Electrical Engineers 5430 Waterbury-Stowe Road Waterbury Center, Vermont 05677 Tel: 802-882-8449 www.EngineeringVermont.com

LANDSCAPE ARCHITECT

J Miller Landscape Architecture


2095 VT Route 18
Waterford, Vermont 05819
Tel: 802-535-8586
www.jmillerlandscape.com


LIST OF DRAWINGS


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		DATE
SITE PLAN		
SCAPE		
	SITE PLAN OSCAPE	

ARCHITECTURAL

SHEET	TITLE	RE\	V DATE	
0				
AD100	BASEMENT - DEMO & EXISTING CONDITIONS			
AD101	LVL 1 - DEMO PLANS & EXISTING CONDITIONS			
A100	SITE PLAN			
A101	LVL 1 - PARTIAL FLOOR PLAN			
A102	LVL 2 - FLOOR PLAN & BASEMENT PLAN			
A201	EXTERIOR ELEVATIONS			
A901	PERSPECTIVE			
A902	PERSPECTIVES			

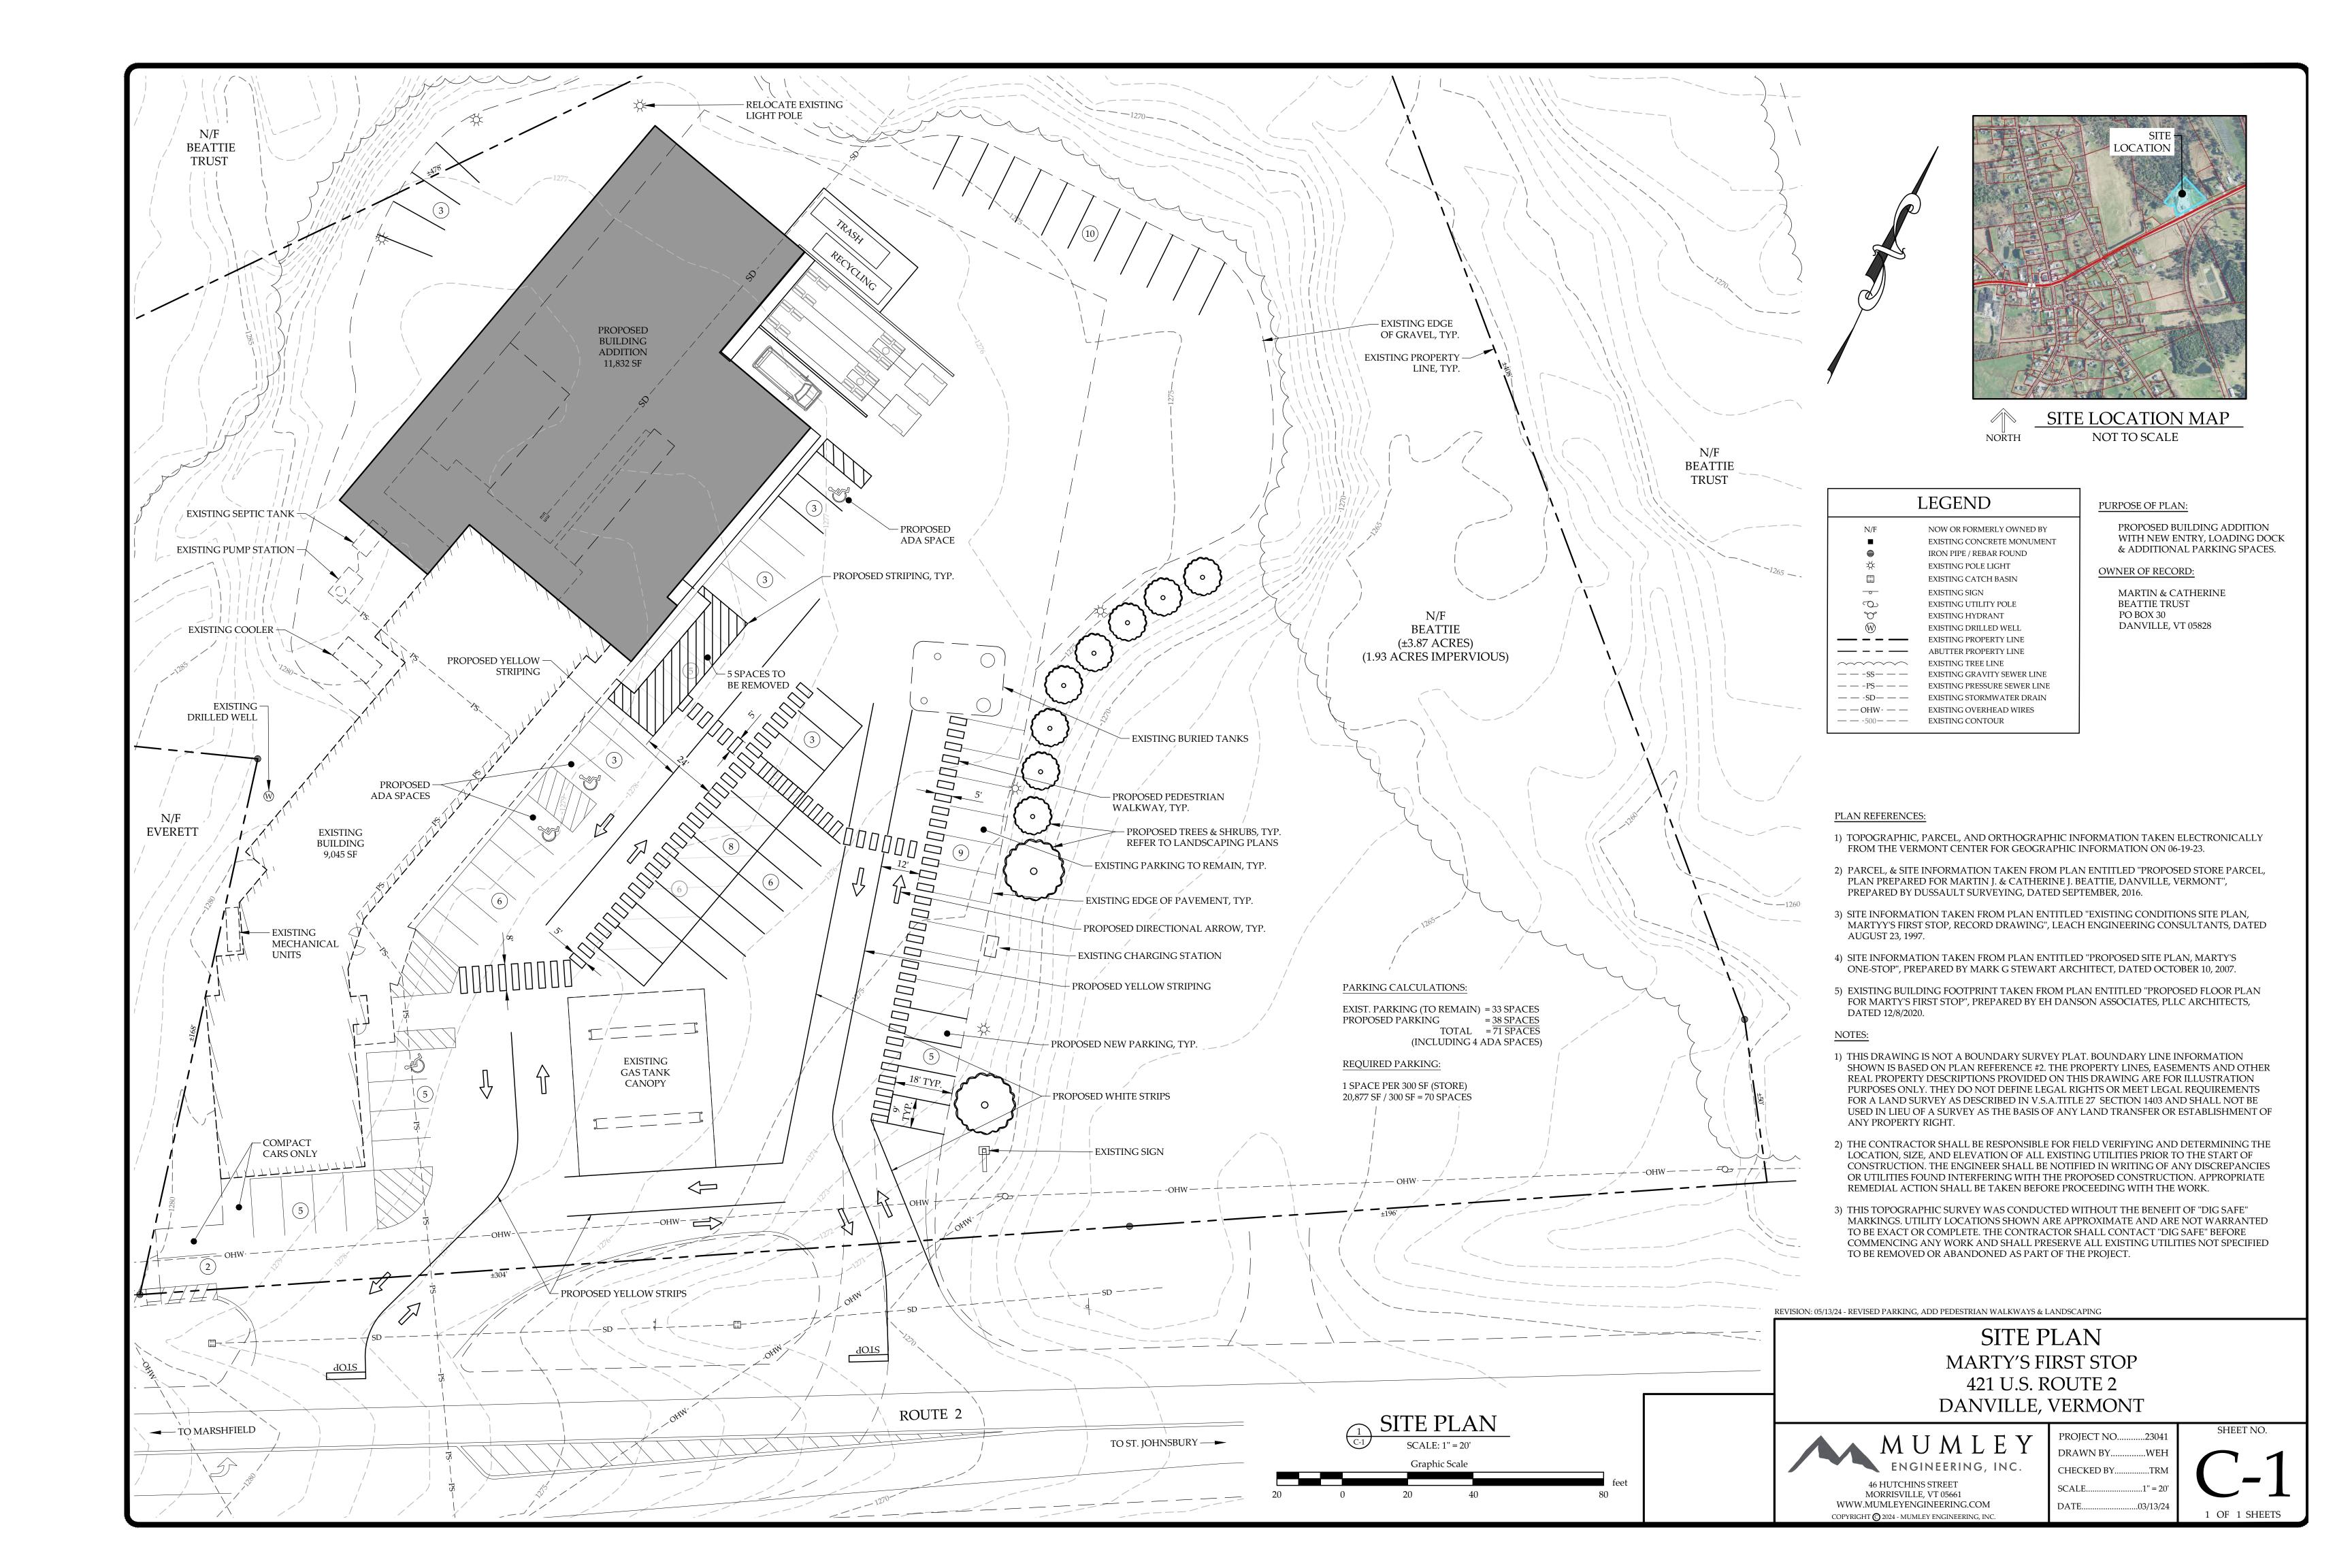

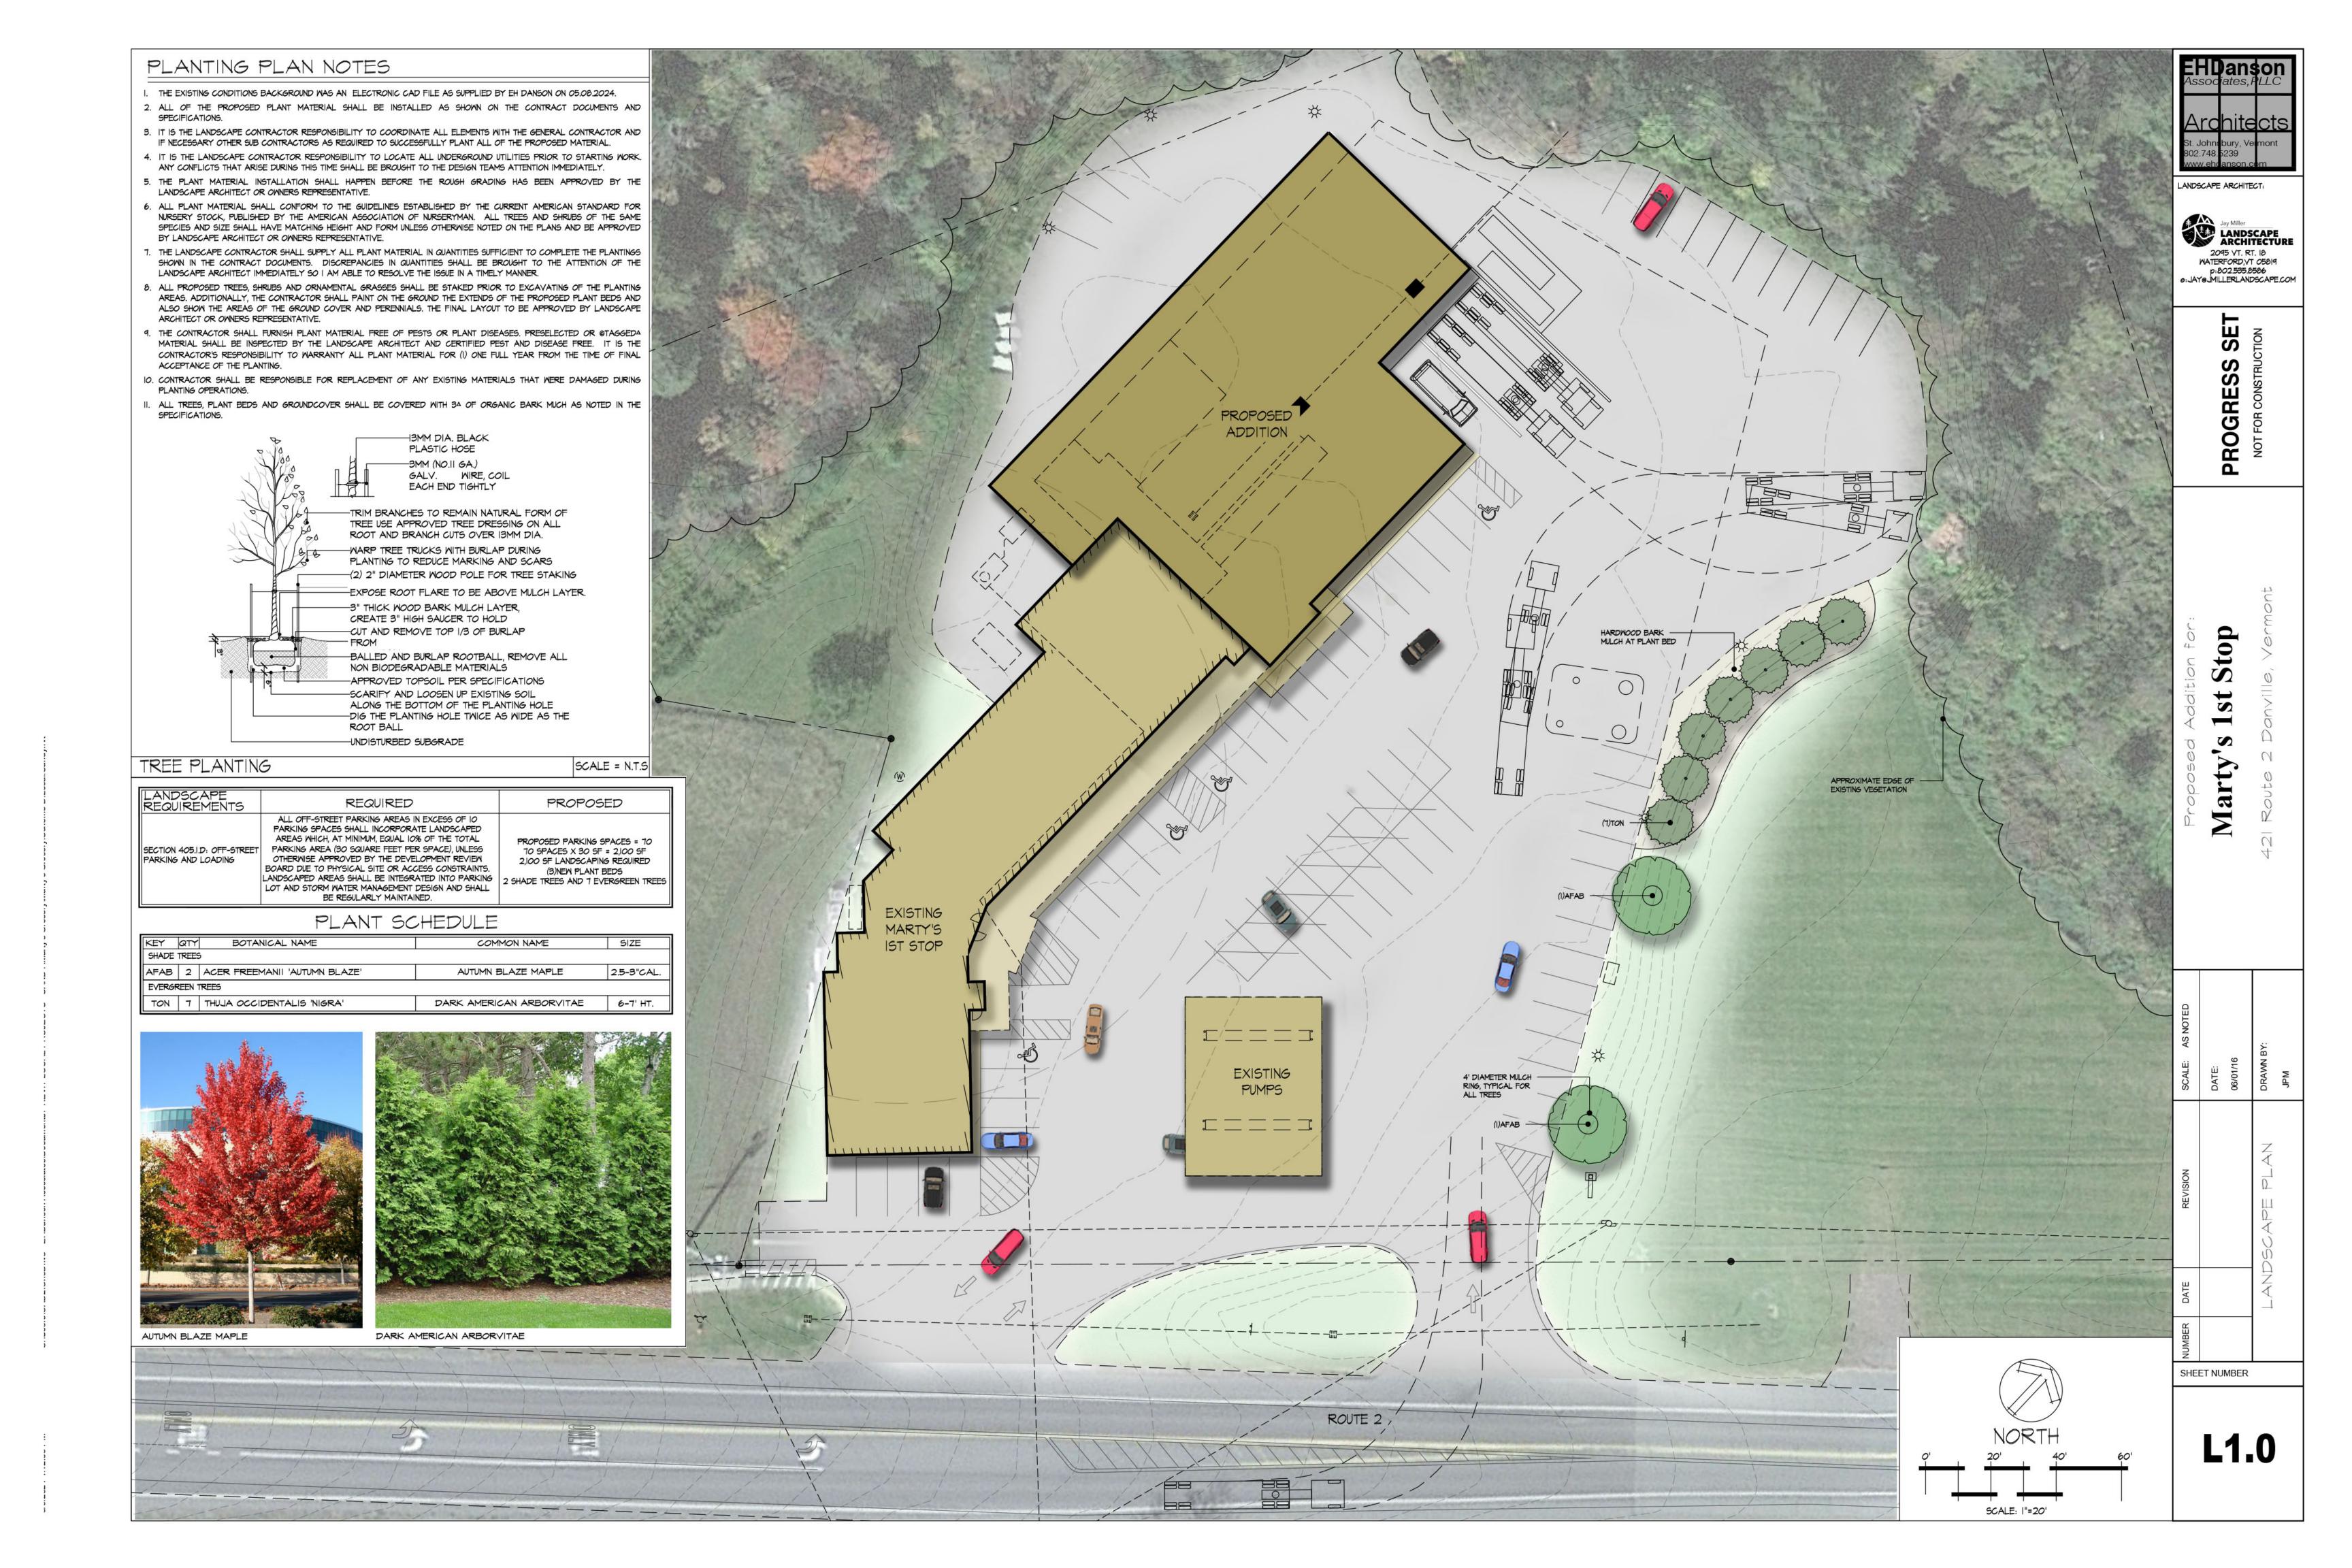

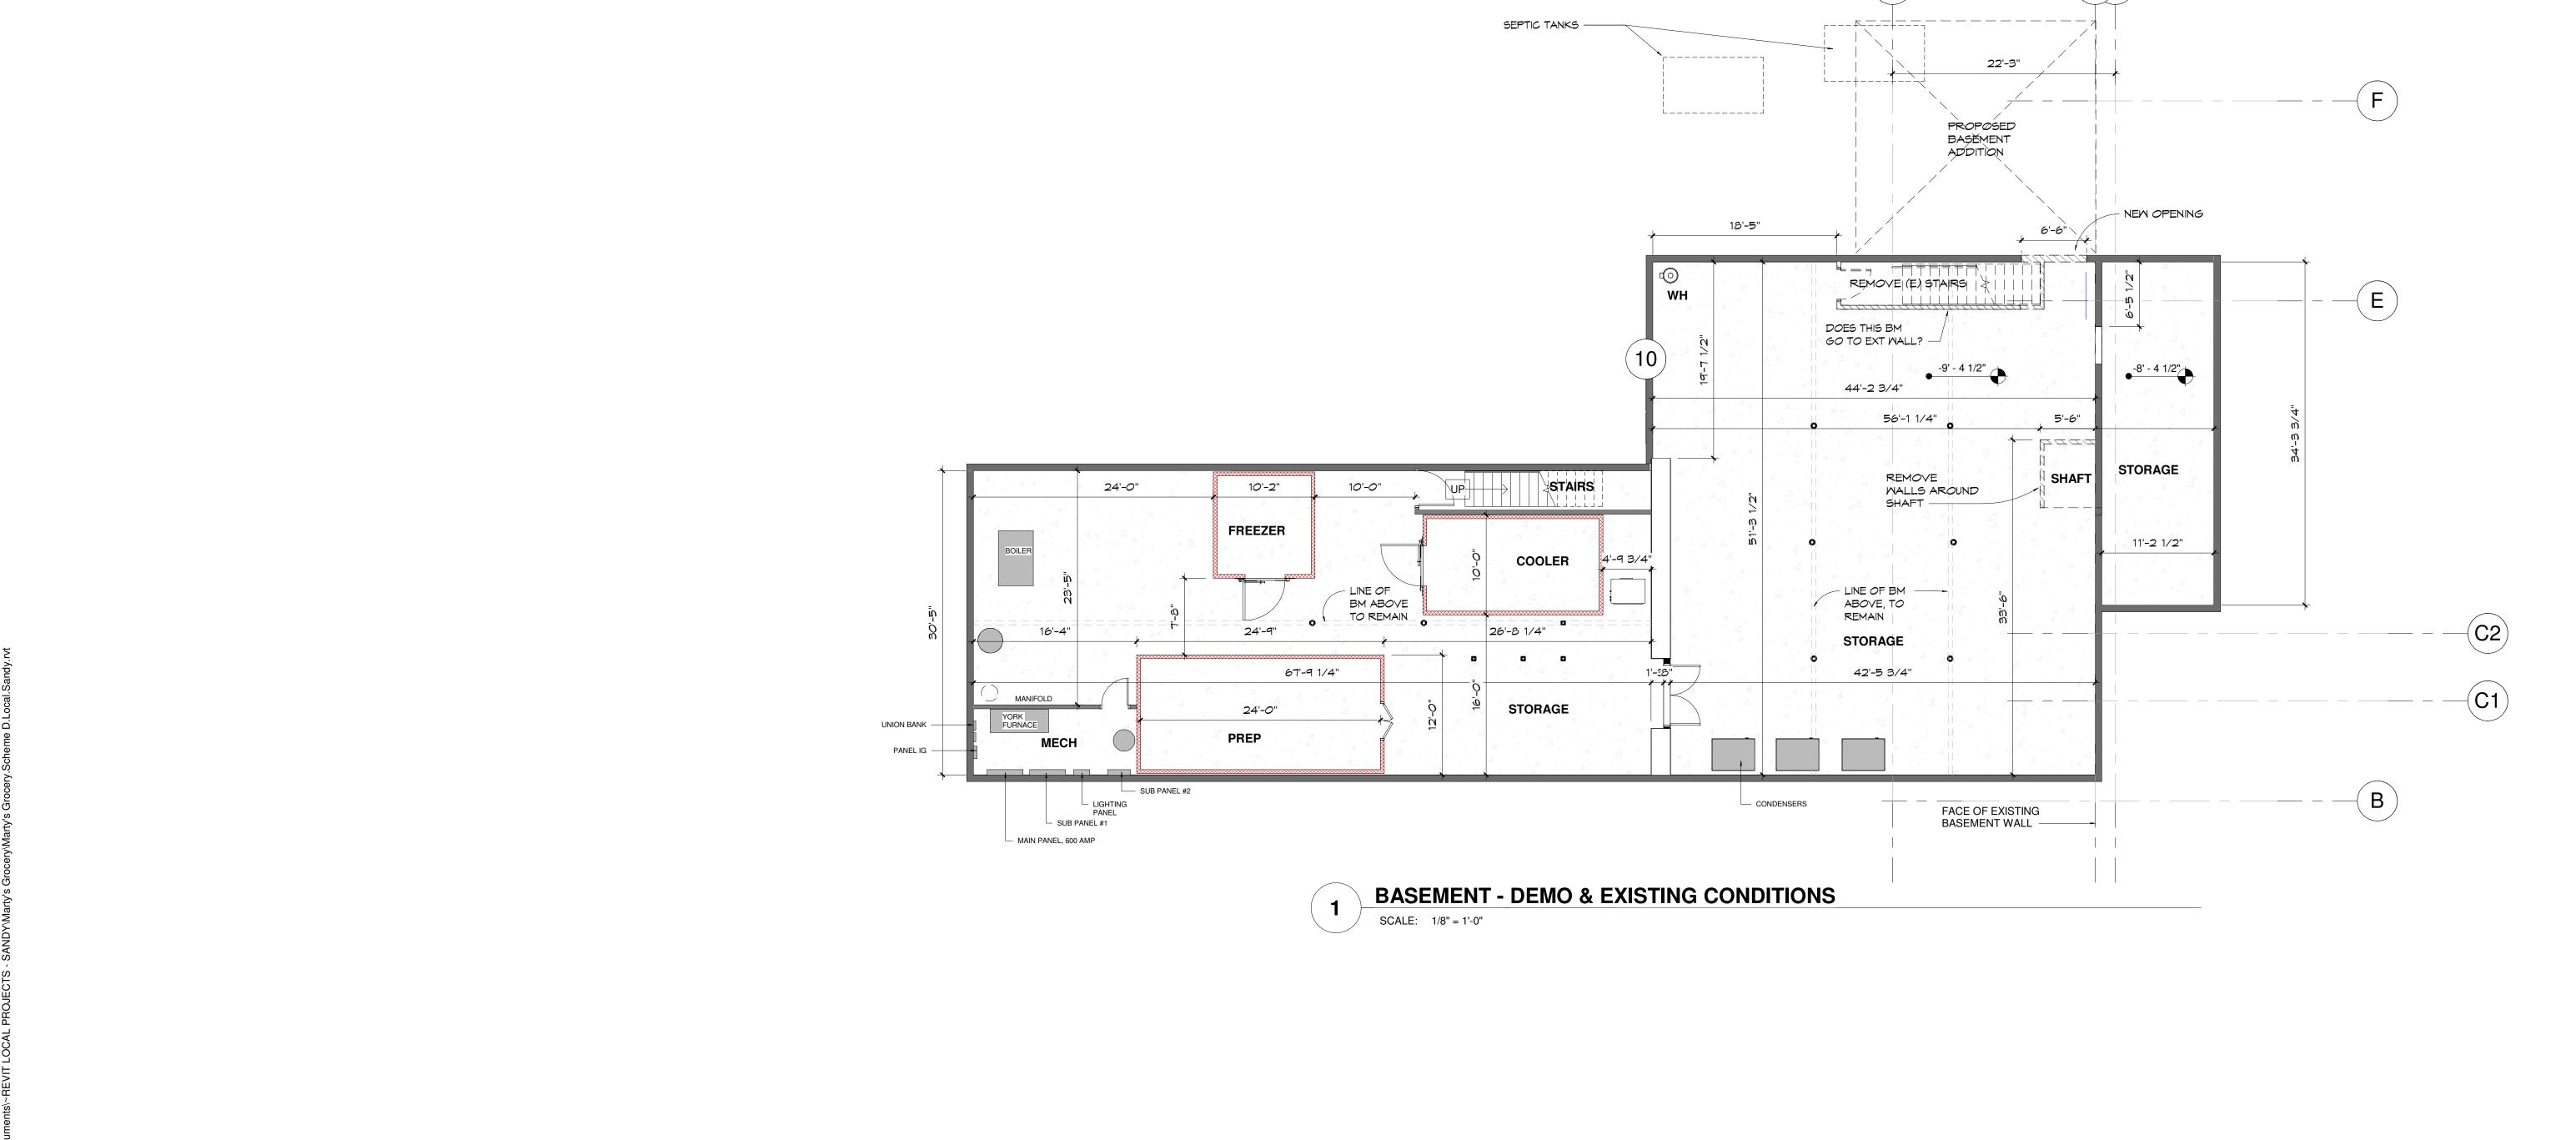

KEYED NOTES

PHASE 1 - DEMO

(1) RE-LOCATE SEPTIC TANK, REFER TO CIVIL DRAWINGS

- REMOVE PARTITION WALLS AND DOORS.
- BASEMENT AREA.

MAY VARY. ORIGINAL DRAWINGS WILL BE AVAILABLE FOR VIEWING. 8) THE CONTRACTORS SHALL TAKE ALL NECESSARY PRECAUTIONS TO PROTECT ALL EXISTING ELEMENTS TO REMAIN FROM DAMAGE THROUGHOUT THE ENTIRE CONSTRUCTION PROCESS. ELEMENTS DAMAGED DURING CONSTRUCTION SHALL BE REPLACED BY THE CONTRACTOR 3) CORDINATE CUTTING PATCHING & DEMOLITION WITH REQUIREMENTS OF AT NO COST TO THE OMNER TO THE SATISFACTION OF THE OMNER AND ARCHITECT. MECHANICAL ELECTRICAL TRADES. ALL EXISTING FINISHES AFFECTED BY MECHANICAL & ELECTRICAL REMOVAL SHALL BE REPAIRED TO MATH 9) PATCH ALL HOLES IN WALLS, FLOORS AND CEILINGS OCCURRED DURING EXISTING ADJACENT CONSTRUCTION. DEMOLITION AND CONSTRUCTION. PROVIDE SMOOTH CONTINUOUS FINISH TO

4) ALL ITEMS DEMOLISHED SHALL BE DISPOSED OF PROPERLY, MEETING ALL APPLICABLE REGULATIONS. ALL PROCEDURES TO FOLLOW ESTABLISHED MASTE MANAGEMENT PLAN.

1) THE INTENT OF THESE DRAWINGS IS TO SHOW A BASIC DEMOLITION AND DOES NOT

RESPONSIBILITY TO DETERMINE AND COORDINATE THE EXTENT OF DEMOLITION WITH ALL

TRADES. IT IS EXPECTED THAT ALL CONTRACTORS WILL REVIEW FIELD CONDITIONS

PRIOR TO SUBMITTING BID AND THEREFORE HAVE KNOWLEDGE OF DEMOLITION

2) EXISTING CONDITIONS BASED ON FIELD OBSERVATION OR GENERALLY OBSERVABLE

ELEMENTS AND ORIGINAL DRAWINGS PROVIDED BY THE OWNER. ACTUAL CONDITIONS

INDICATE EVERY INDIVIDUAL ITEM TO BE REMOVED. IT IS THE CONTRACTORS

SHEET NOTES

REQUIREMENTS BASED ON THE PROJECT SCOPE.

5) SCRAPE, SAND, CLEAN AN PREPARE ALL SURFACES TO REMAIN IN PREPARATION FOR NEW FINISH WHERE INDICATED ON THE FINISH SCHEDULE AND/OR DRAWINGS. 10) DAMAGED CAUSED TO MATERIAL OF SURFACES NOT SCHEDULED TO BE REMOVED, BECOMES THE RESPONSIBILITY OF THE CONTRACTOR AND MUST BE REPAIRED OR REPLACED TO THE SATISFACTION OF THE ARCHITECT AND OWNER.

MATCH ADJACENT EXISTING CONSTRUCTION. NO TRANSITION LINES ARE TO BE

6) THE EXISTING CONCRETE SLAB WILL BE REQUIRED TO BE CUT AND PATCH TO

ACCOMMODATE INSTALLATION OF NEW PLUMBING. THE CONTRACTOR IS RESPONSIBLE FOR CALCULATION THE AREA OF THE CONCRETE SLAB TO BE

CONSTRUCTION WHETHER OR NOT IT IS SHOWN ON DEMOLITION DRAWINGS.

7) CUT AND PATCH TO ACCOMMODATE THE INSTALLATION OF ALL NEW

IN SLAB REMOVAL AREAS NOT CALCULATED.

VISIBLE AFTER PATCH WORK IS COMPLETE.

COORDINATED SIZES ACCORDINGLY.

REMOVED & REPLACED. THERE WILL BE NO ADDITIONAL COST FOR INCREASES

AD100

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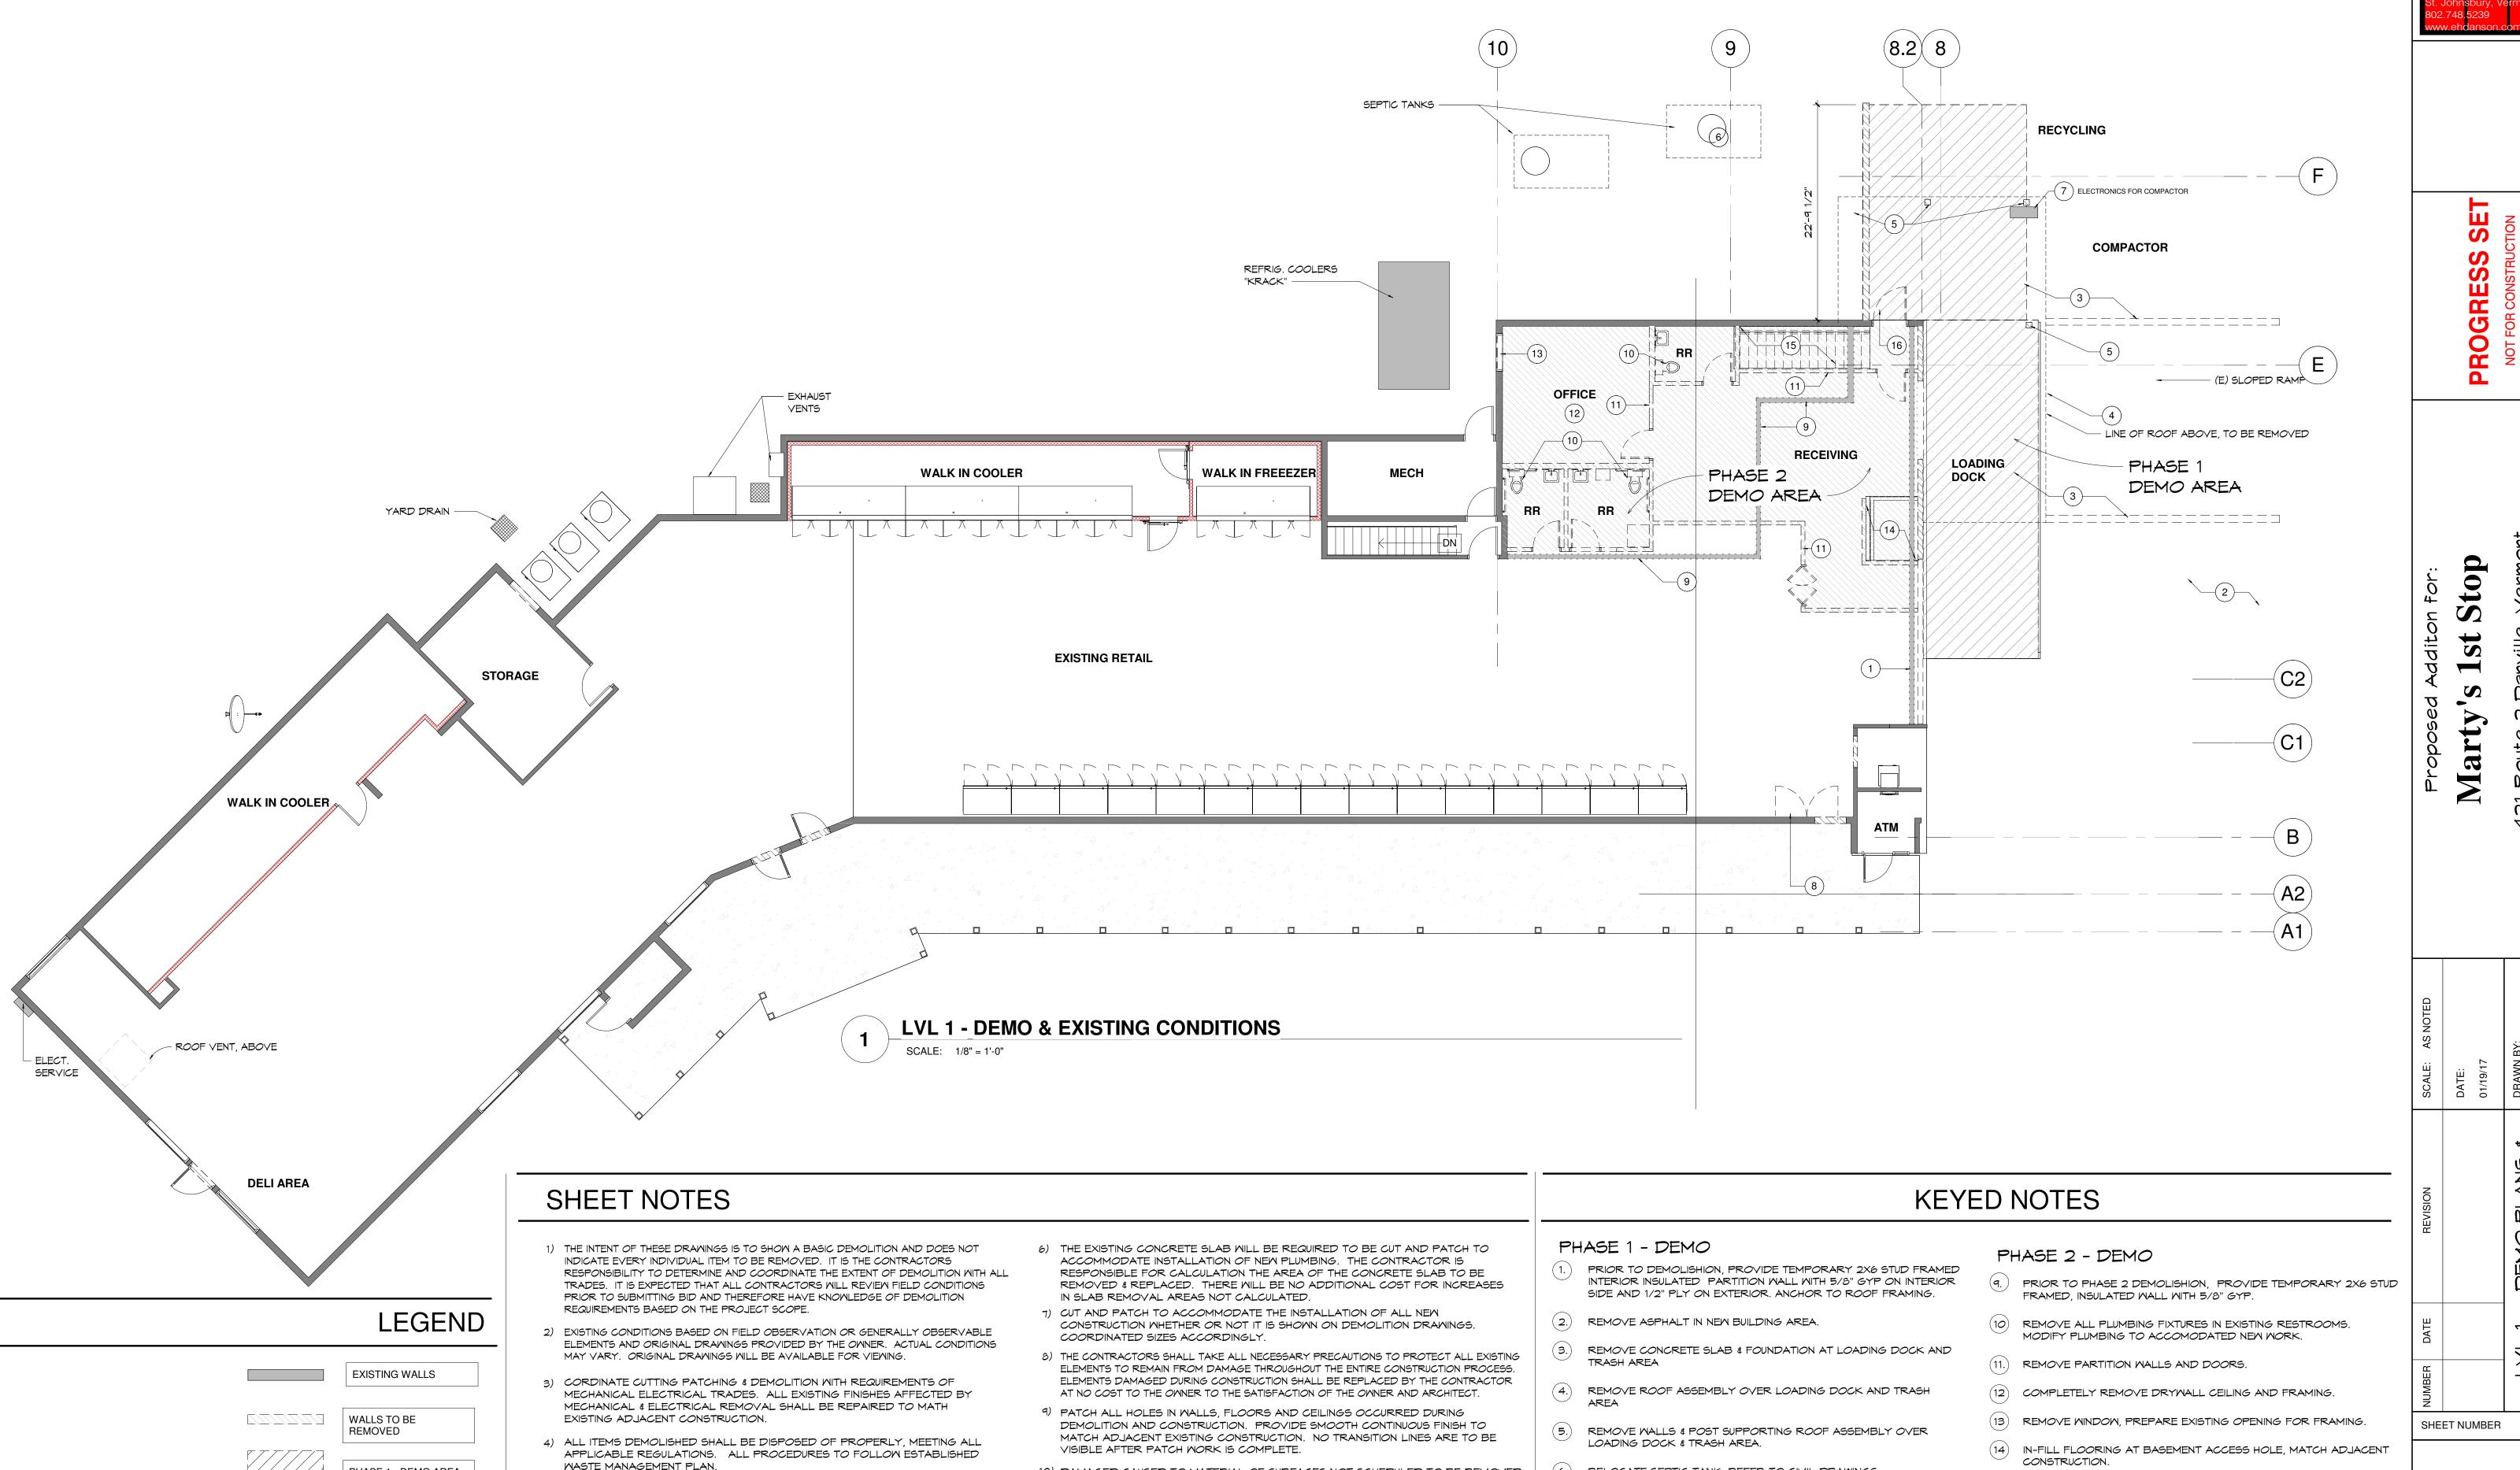
LEGEND

EXISTING WALLS WALLS TO BE REMOVED PHASE 1 - DEMO AREA PHASE 2 - DEMO AREA

PHASE 2 - DEMO

(2) REMOVE STAIRS. INFILL FLOORING, MATCH EXISTING CONSTRUCTION

4 CUT OPEINING INTO EXISTING FOUNDATION WALL TO ACCESS NEW



10) DAMAGED CAUSED TO MATERIAL OF SURFACES NOT SCHEDULED TO BE REMOVED, BECOMES THE RESPONSIBILITY OF THE CONTRACTOR AND MUST BE REPAIRED OR

REPLACED TO THE SATISFACTION OF THE ARCHITECT AND OWNER.

(6.) RELOCATE SEPTIC TANK, REFER TO CIVIL DRAWINGS.

(7.) REMOVE AND RE-INSTALL COMPACTOR ELECTRONICS.

PHASE 1. VERIFY WITH DOOR SIZE WITH OWNER.

8. ADD TEMPORARY RECEIVING DOOR DURING CONSTRUCTION OF

MASTE MANAGEMENT PLAN.

5) SCRAPE, SAND, CLEAN AN PREPARE ALL SURFACES TO REMAIN IN PREPARATION

FOR NEW FINISH WHERE INDICATED ON THE FINISH SCHEDULE AND/OR DRAWINGS.

PHASE 1 - DEMO AREA

PHASE 2 - DEMO AREA

DEMO PLANS 6 CONDITIONS


AD101

15) REMOVE STAIRS, IN-FILL FLOORING, MATCH ADJACENT

(16) MAINTAIN DOOR UNTIL PHASE 2 CONSTRUCTION COMPLETE FOR

CONSTRUCTION.

PUBLIC ACCESS TO RESTROOM.

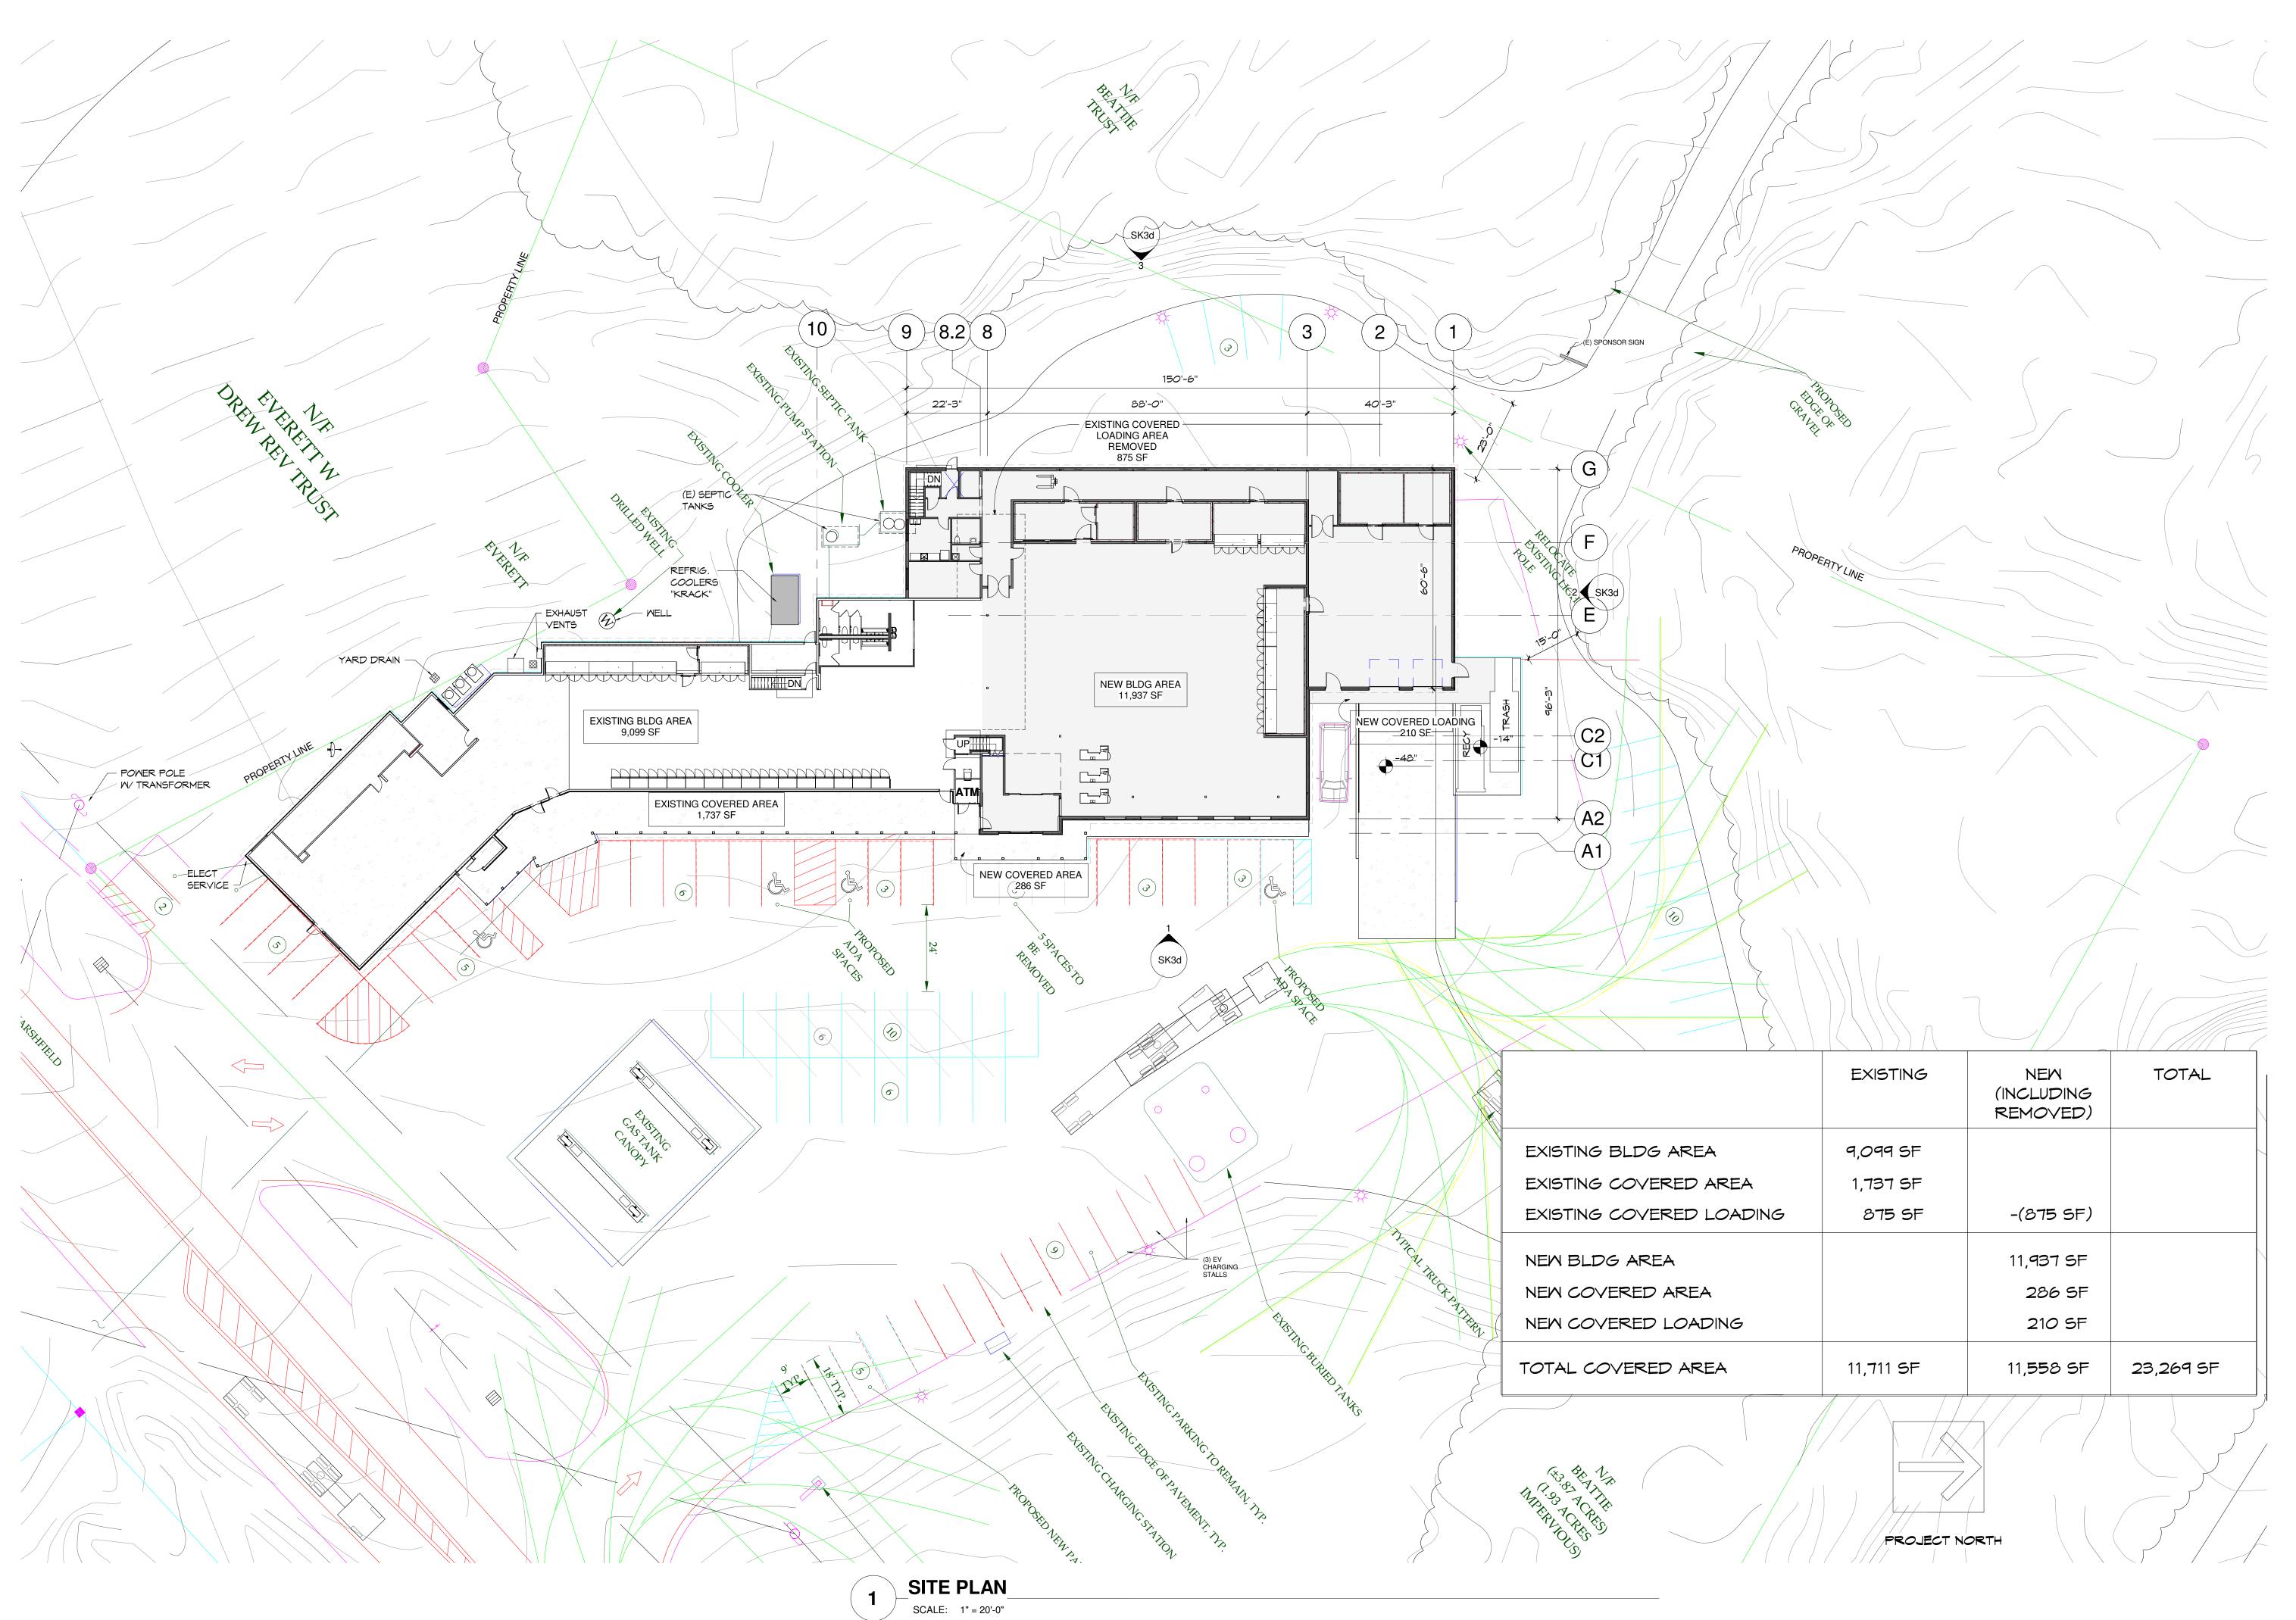



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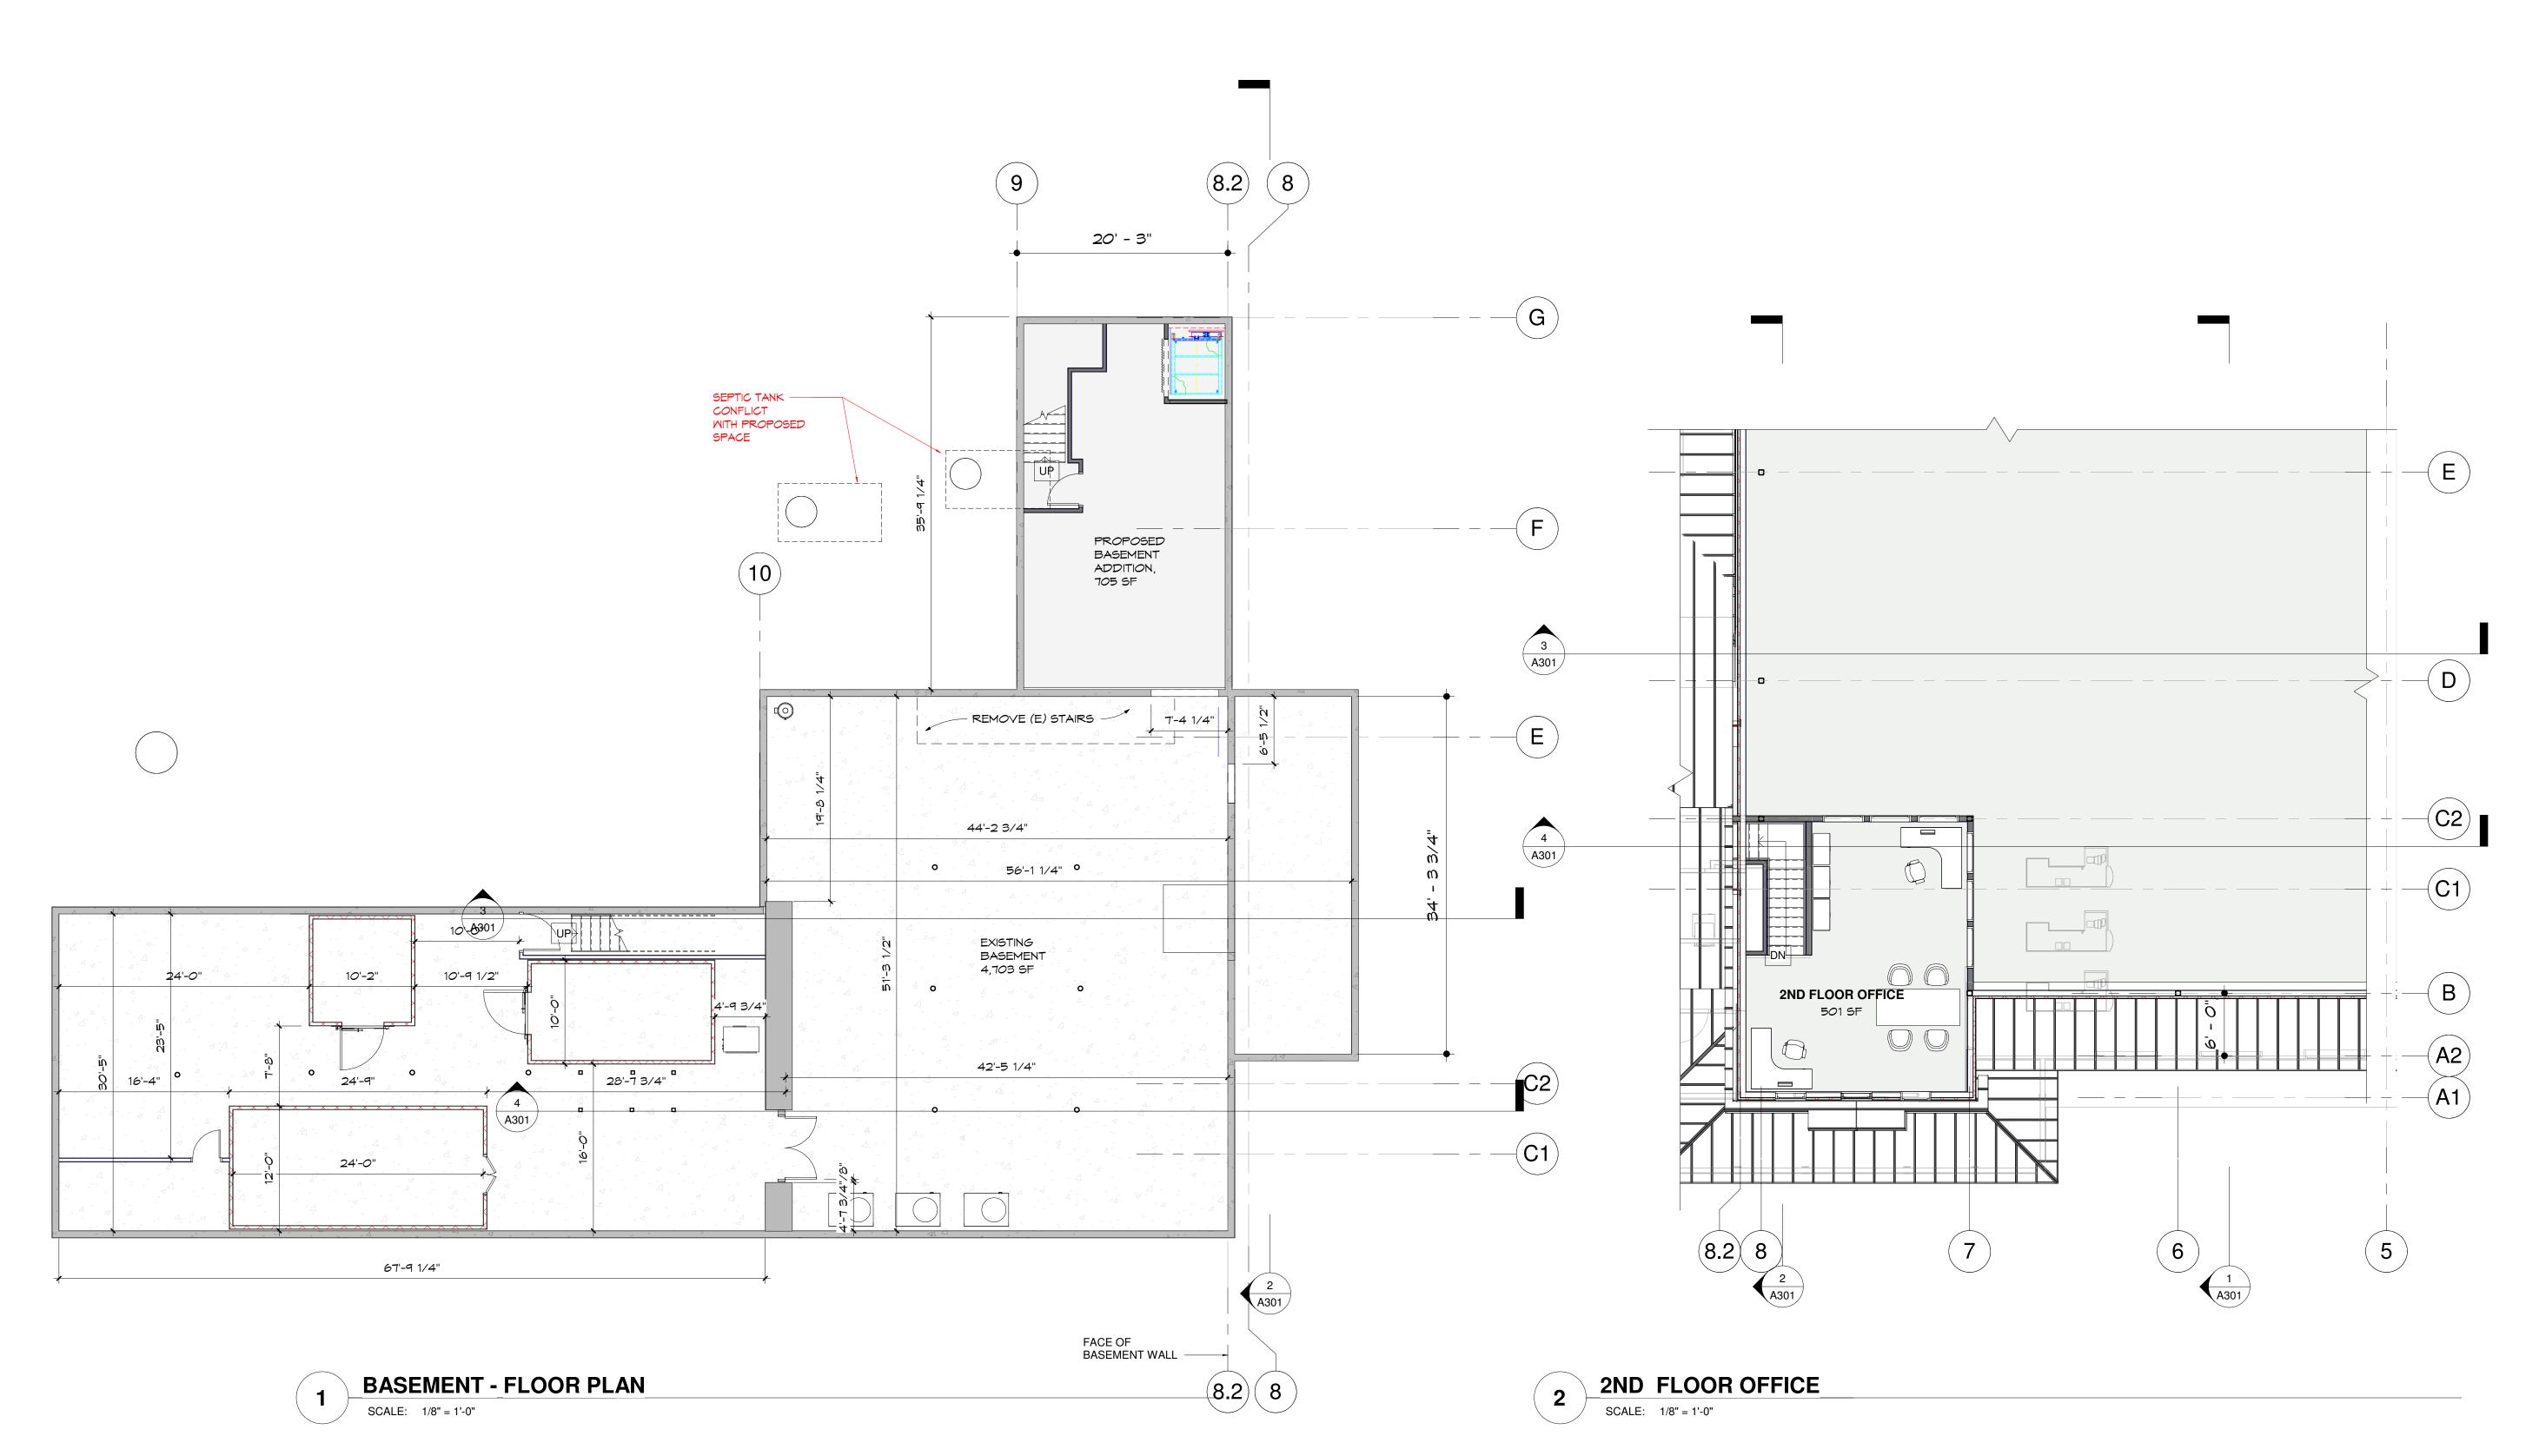
Proposed Additon For:

Marty's 1st Stop

DATE:
01/15/24


FLOOR PLAN & DRAWN BY:
SLM

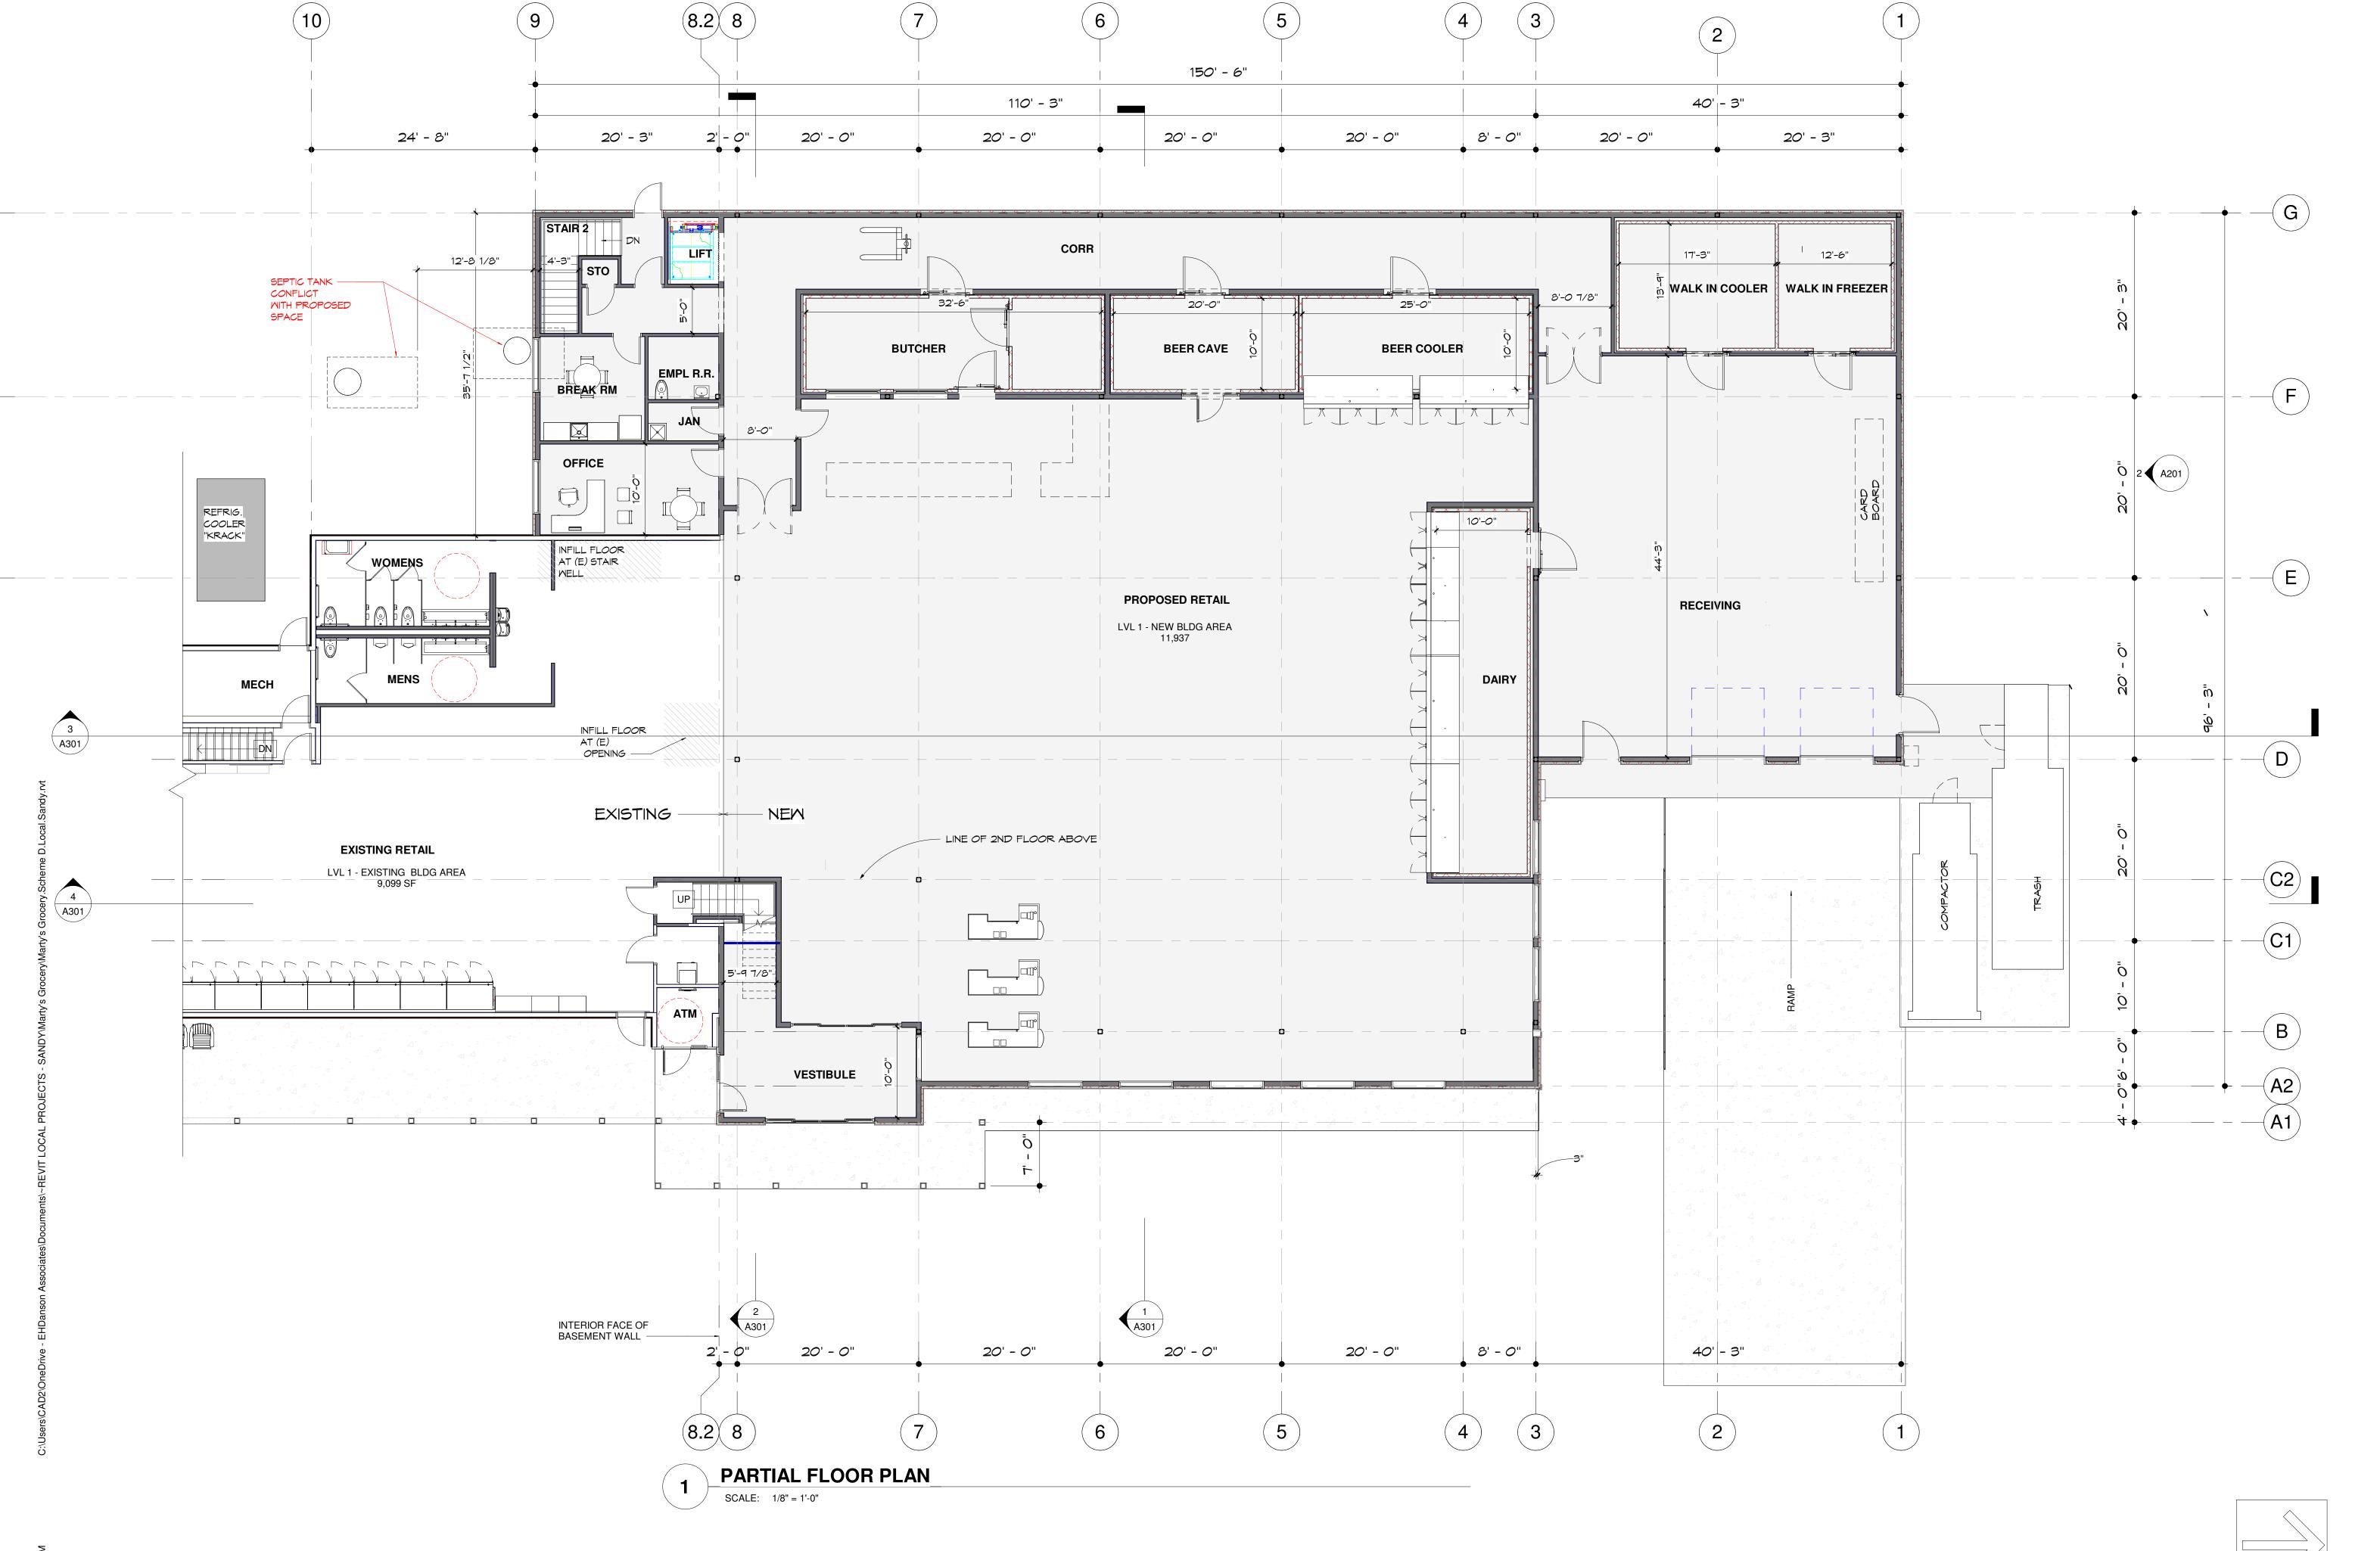SHEET NUMBER

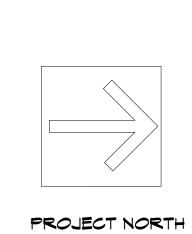

WEST ELEVATION

SCALE: 1/8" = 1'-0"

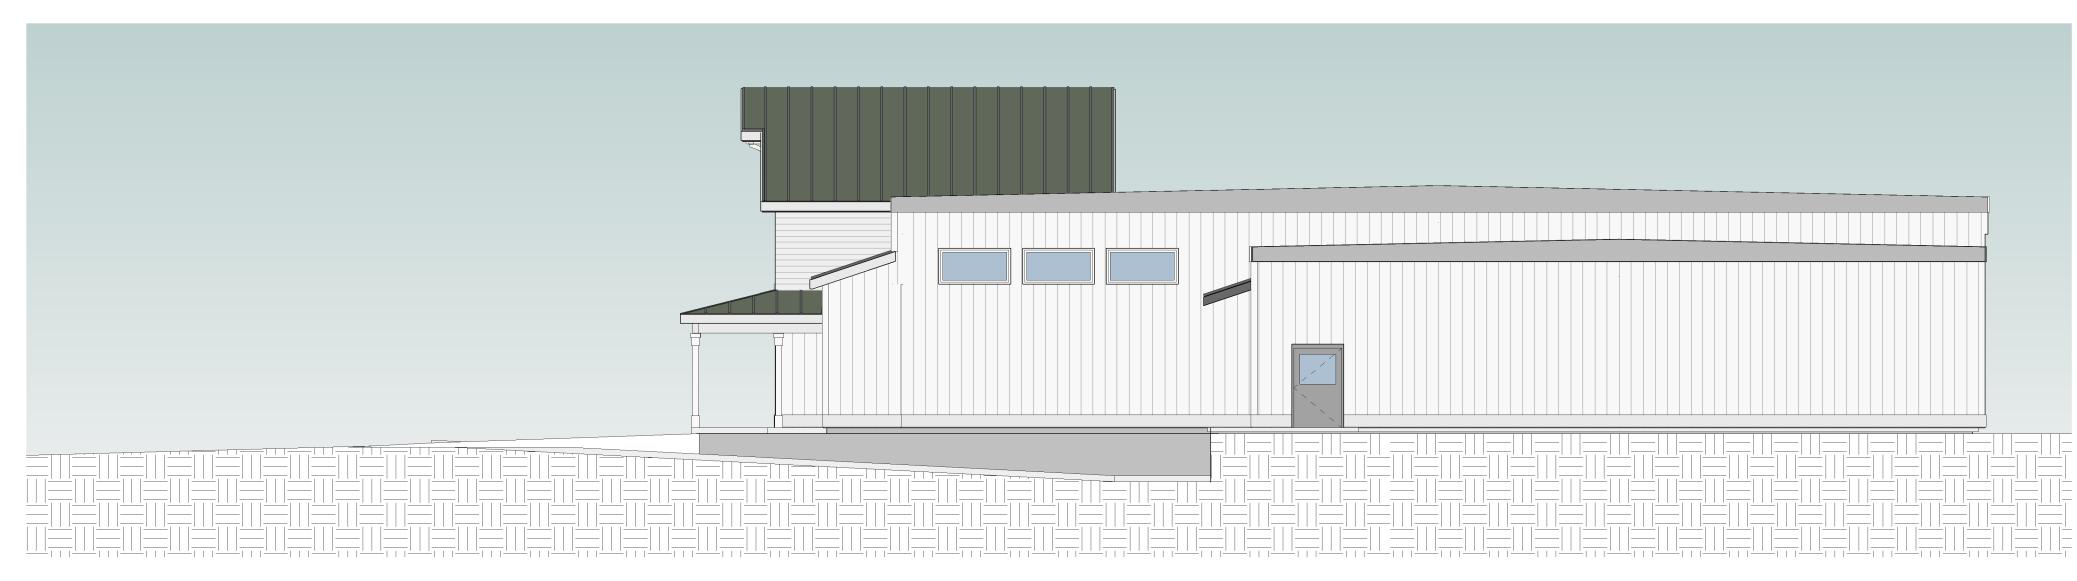

NORTH ELEVATION

SCALE: 1/8" = 1'-0"



SCALE: 1/8" = 1'-0"

357 Western Avenue

Suite 104
P.O. Box 4069
St. Johnsbury, Vermont 05819
tel: 802 748 5239
fax: 802 748 1085
www.ehdanson.com

PROGRESS NOT FOR CONSTRUCT

SHEET NUMBER



357 Western Avenue Suite 104 P.O. Box 4069 St. Johnsbury, Vermont 05819 tel: 802 748 5239 fax: 802 748 1085 www.ehdanson.com

PROGRESS SET NOT FOR CONSTRUCTION

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